

REGISTERE STATE OF WASHINGTON 12-14-20 permit: revisions: drawn by: LMD checked by: MMJ SHEET

WRITTEN DIMENSIONS ON THIS DRAWING SHALL HAVE PRECEDENCE OVER SCALED DIMENSIONS. CONTRACTOR SHALL VERIFY ALL DIMENSIONS, CONDITIONS, ETC. PERTAINING TO THE WORK BEFORE PROCEEDING. THE OWNER MUST BE NOTIFIED OF ANY VARIATIONS FROM THE DIMENSIONS AND/OR CONDITIONS SHOWN ON THESE DRAWINGS. ANY SUCH VARIATION SHALL BE RESOLVED BY THE OWNER PRIOR TO PROCEEDING WITH THE WORK, OR THE CONTRACTOR SHALL ACCEPT FULL RESPONSIBILITY FOR THE COST TO RECTIFY SAME.



## REAR ELEVATION SEE GENERAL NOTES SCALE: 1/4" = 1'-0"



LEFT ELEVATION

SEE GENERAL NOTES SCALE: 1/4" = 1'-0"




THE BARCLAY
PLAN 3846

date: 12-14-20 permit: revisions:

drawn by: LMD checked by: MMJ

SHEET

A2

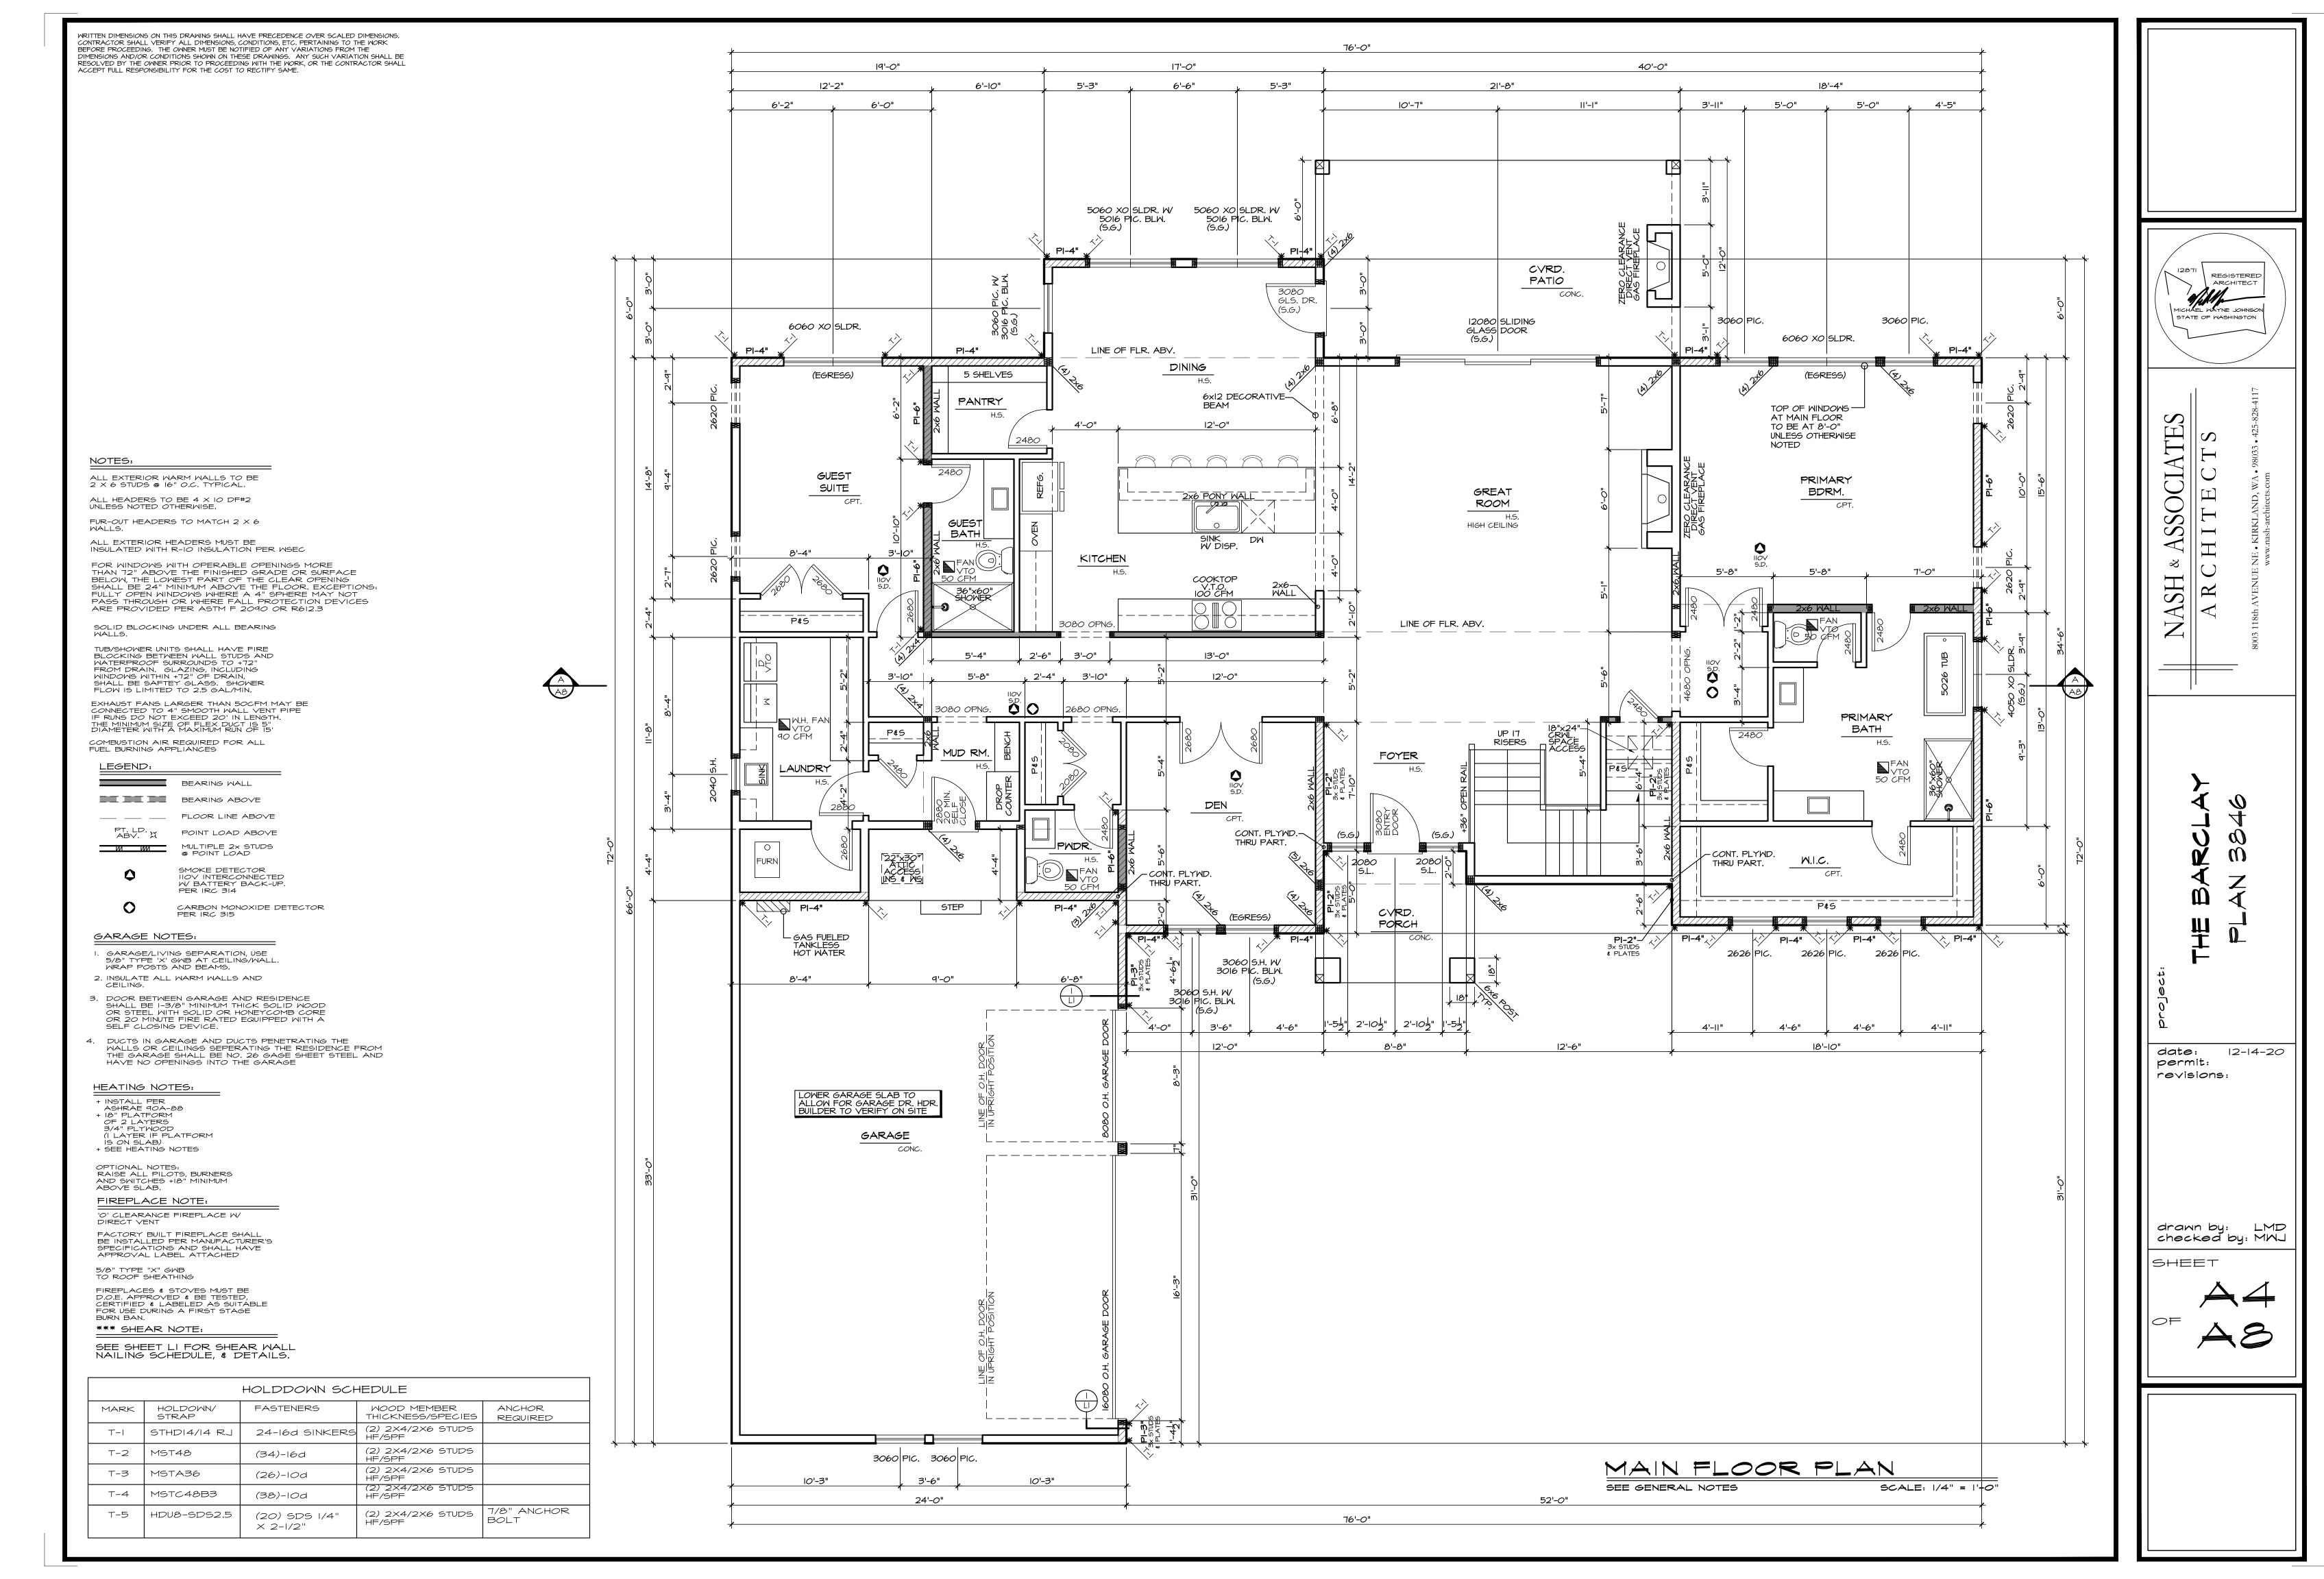

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ALL EXTERIOR WARM WALLS TO BE  $2 \times 6$  STUDS @ 16" O.C. TYPICAL. ALL HEADERS TO BE 4 X 8 DF#2 UNLESS NOTED OTHERWISE.

FUR-OUT HEADERS TO MATCH 2 X 6

ALL EXTERIOR HEADERS MUST BE INSULATED WITH R-IO INSULATION PER WSEC

FOR WINDOWS WITH OPERABLE OPENINGS MORE
THAN 72" ABOVE THE FINISHED GRADE OR SURFACE
BELOW, THE LOWEST PART OF THE CLEAR OPENING
SHALL BE 24" MINIMUM ABOVE THE FLOOR. EXCEPTIONS:
FULLY OPEN WINDOWS WHERE A 4" SPHERE MAY NOT
PASS THROUGH OR WHERE FALL PROTECTION DEVICES
ARE PROVIDED PER ASTM F 2090 OR R612.3

SOLID BLOCKING UNDER ALL BEARING WALLS.

TUB/SHOWER UNITS SHALL HAVE FIRE BLOCKING BETWEEN WALL STUDS AND WATERPROOF SURROUNDS TO +72" FROM DRAIN. GLAZING, INCLUDING WINDOWS WITHIN +72" OF DRAIN, SHALL BE SAFTEY GLASS. SHOWER FLOW IS LIMITED TO 2.5 GAL/MIN.

EXHAUST FANS LARGER THAN 50CFM MAY BE CONNECTED TO 4" SMOOTH WALL VENT PIPE IF RUNS DO NOT EXCEED 20' IN LENGTH. THE MINIMUM SIZE OF FLEX DUCT IS 5" DIAMETER WITH A MAXIMUM RUN OF IS'

COMBUSTION AIR REQUIRED FOR ALL FUEL BURNING APPLIANCES

BEARING WALL BEARING ABOVE

\_\_\_ FLOOR LINE ABOVE

PT. LD. X POINT LOAD ABOVE MULTIPLE 2× STUDS


POINT LOAD SMOKE DETECTOR IIOV INTERCONNECTED W/ BATTERY BACK-UP. PER IRC 314

CARBON MONOXIDE DETECTOR PER IRC 315

\*\*\* SHEAR NOTE:

SEE SHEET LI FOR SHEAR WALL NAILING SCHEDULE, & DETAILS.

HOLDDOWN SCHEDULE				
MARK	HOLDOWN/ STRAP	FASTENERS	WOOD MEMBER THICKNESS/SPECIES	ANCHOR REQUIRED
T-I	STHD14/14 RJ	24-16d SINKERS	(2) 2X4/2X6 STUDS HF/SPF	
T-2	MST48	(34)-16d	(2) 2X4/2X6 STUDS HF/SPF	
T-3	MSTA36	(26)-10d	(2) 2X4/2X6 STUDS HF/SPF	
T-4	MSTC48B3	(38)-10d	(2) 2X4/2X6 STUDS HF/SPF	
T-5	HDU8-SDS2.5	(20) SDS 1/4" X 2-1/2"	(2) 2X4/2X6 STUDS HF/SPF	7/8" ANCHOR BOLT

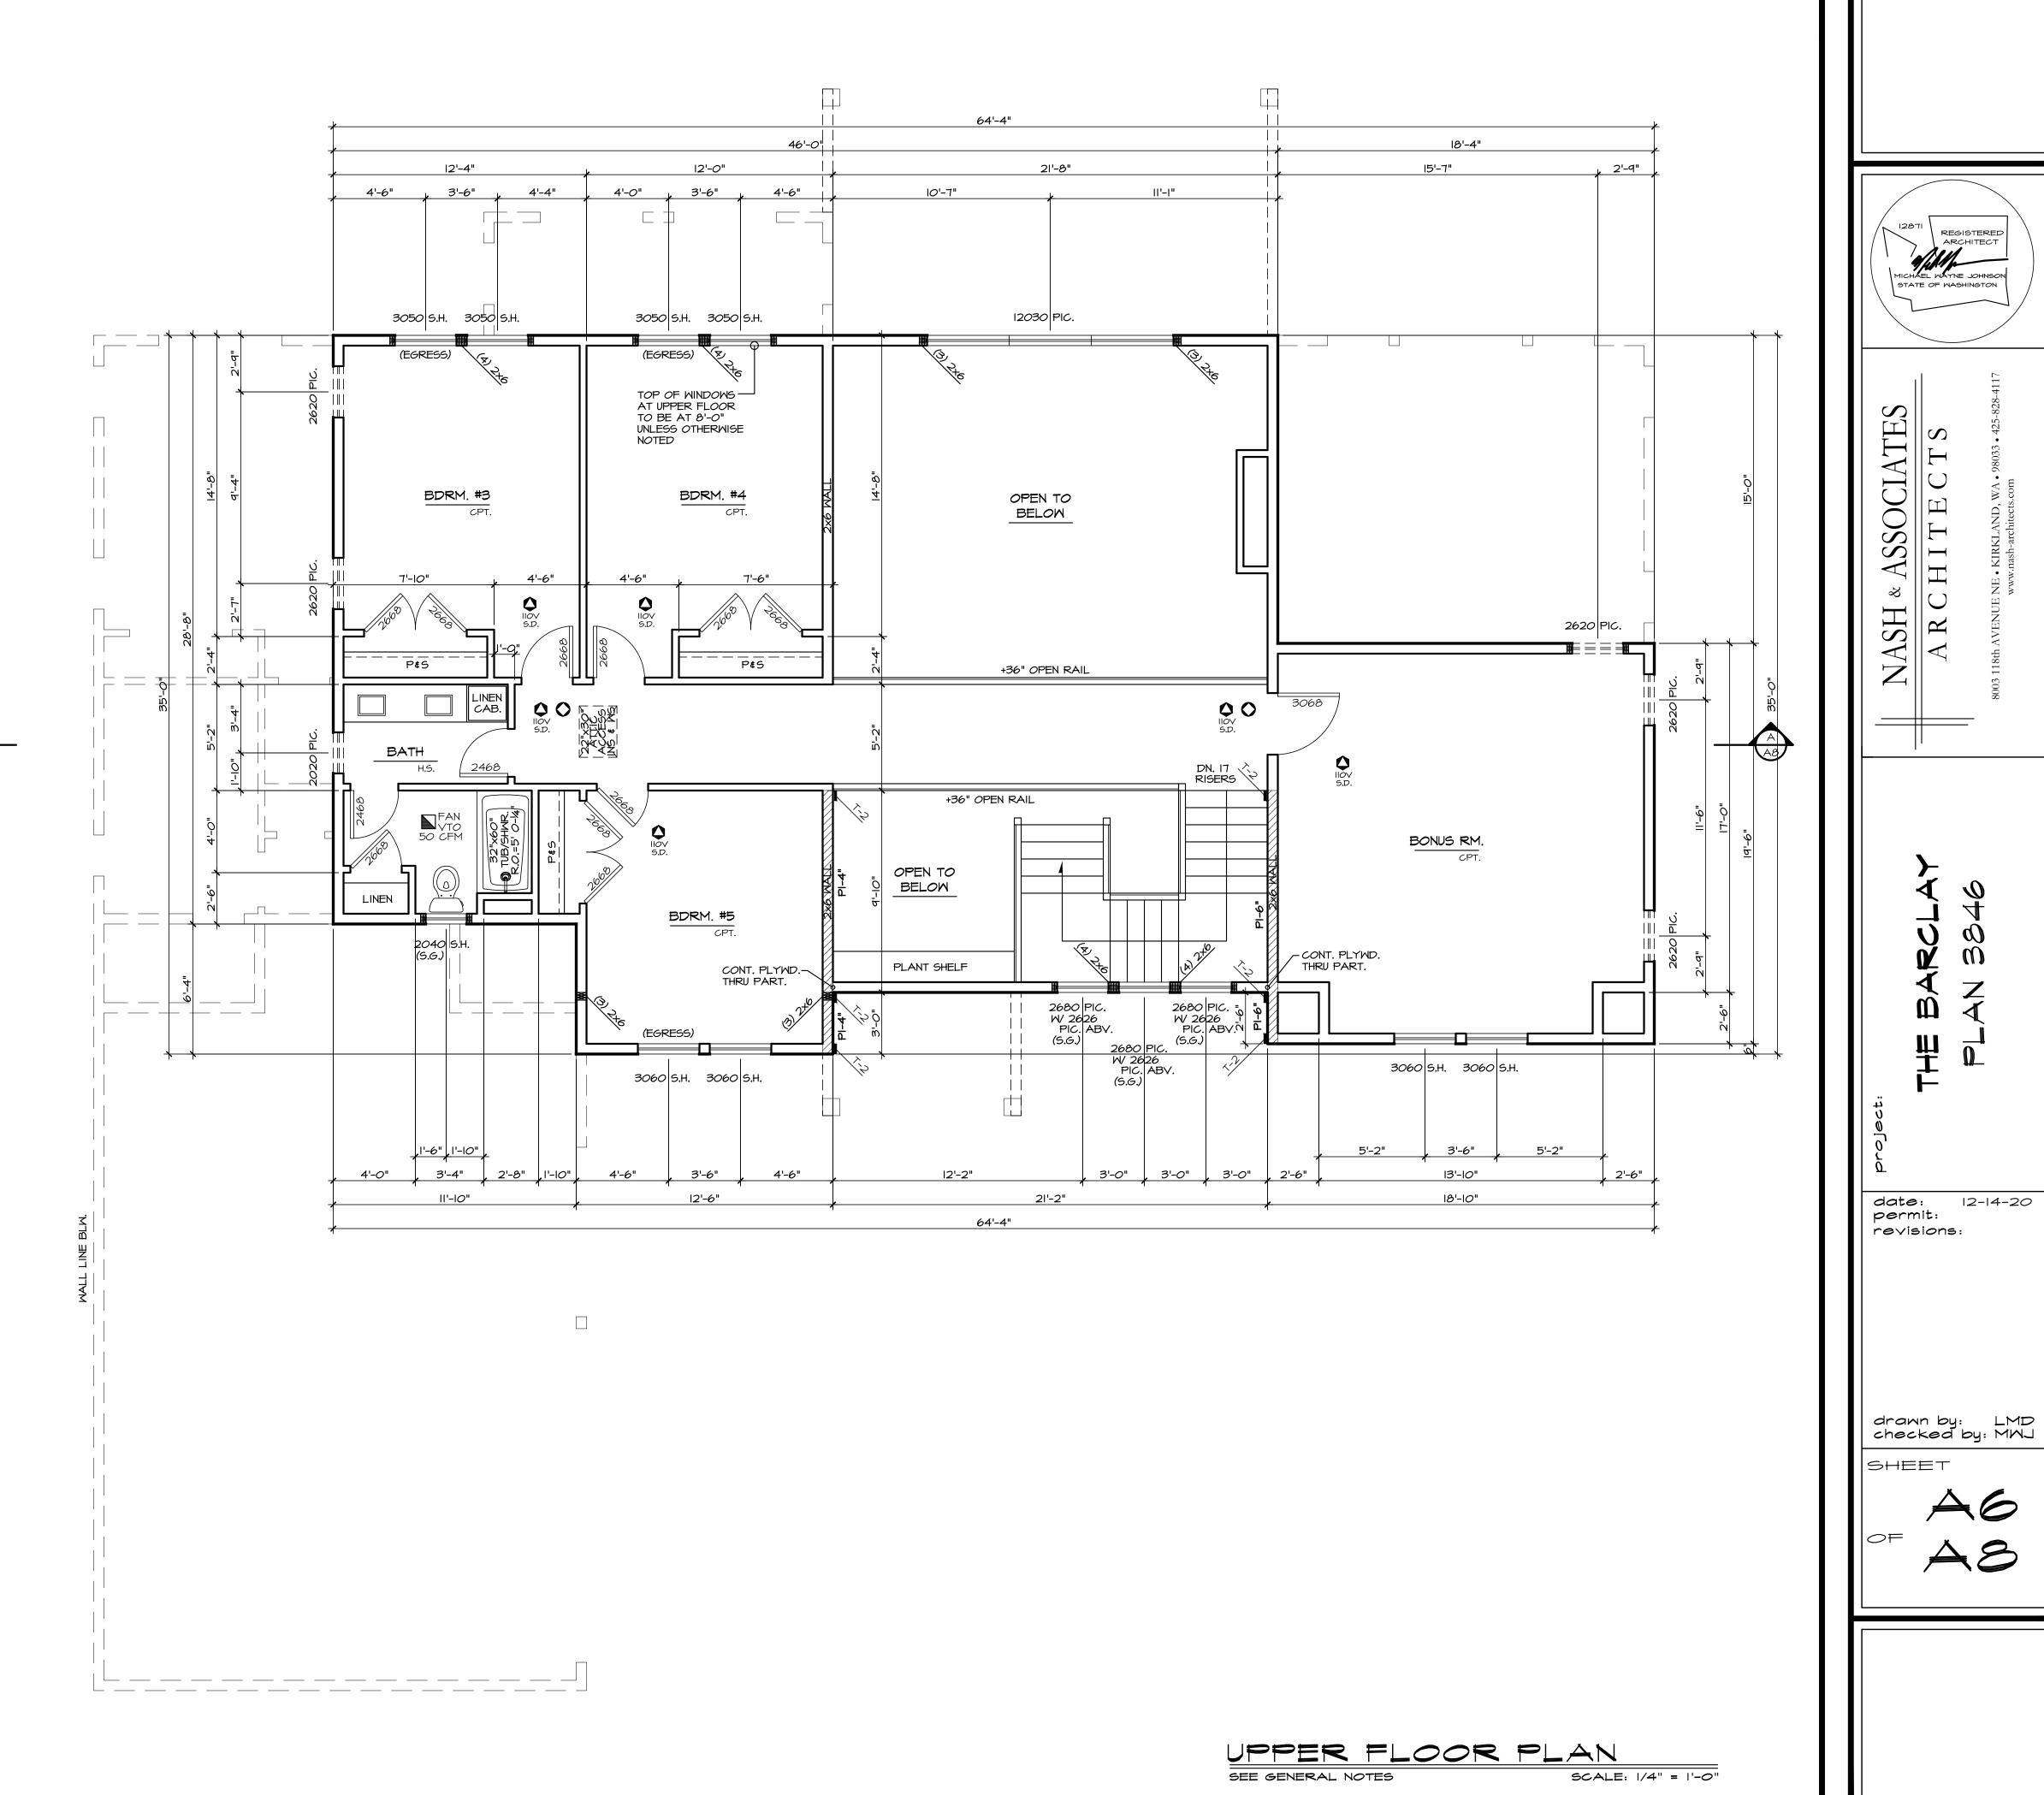

REGISTERED

12-14-20

STATE OF WASHINGTON